


MECHANICAL MEZZANINE
SANITARY & VENT PLAN
SCALE: 3/32" = 1'-0"

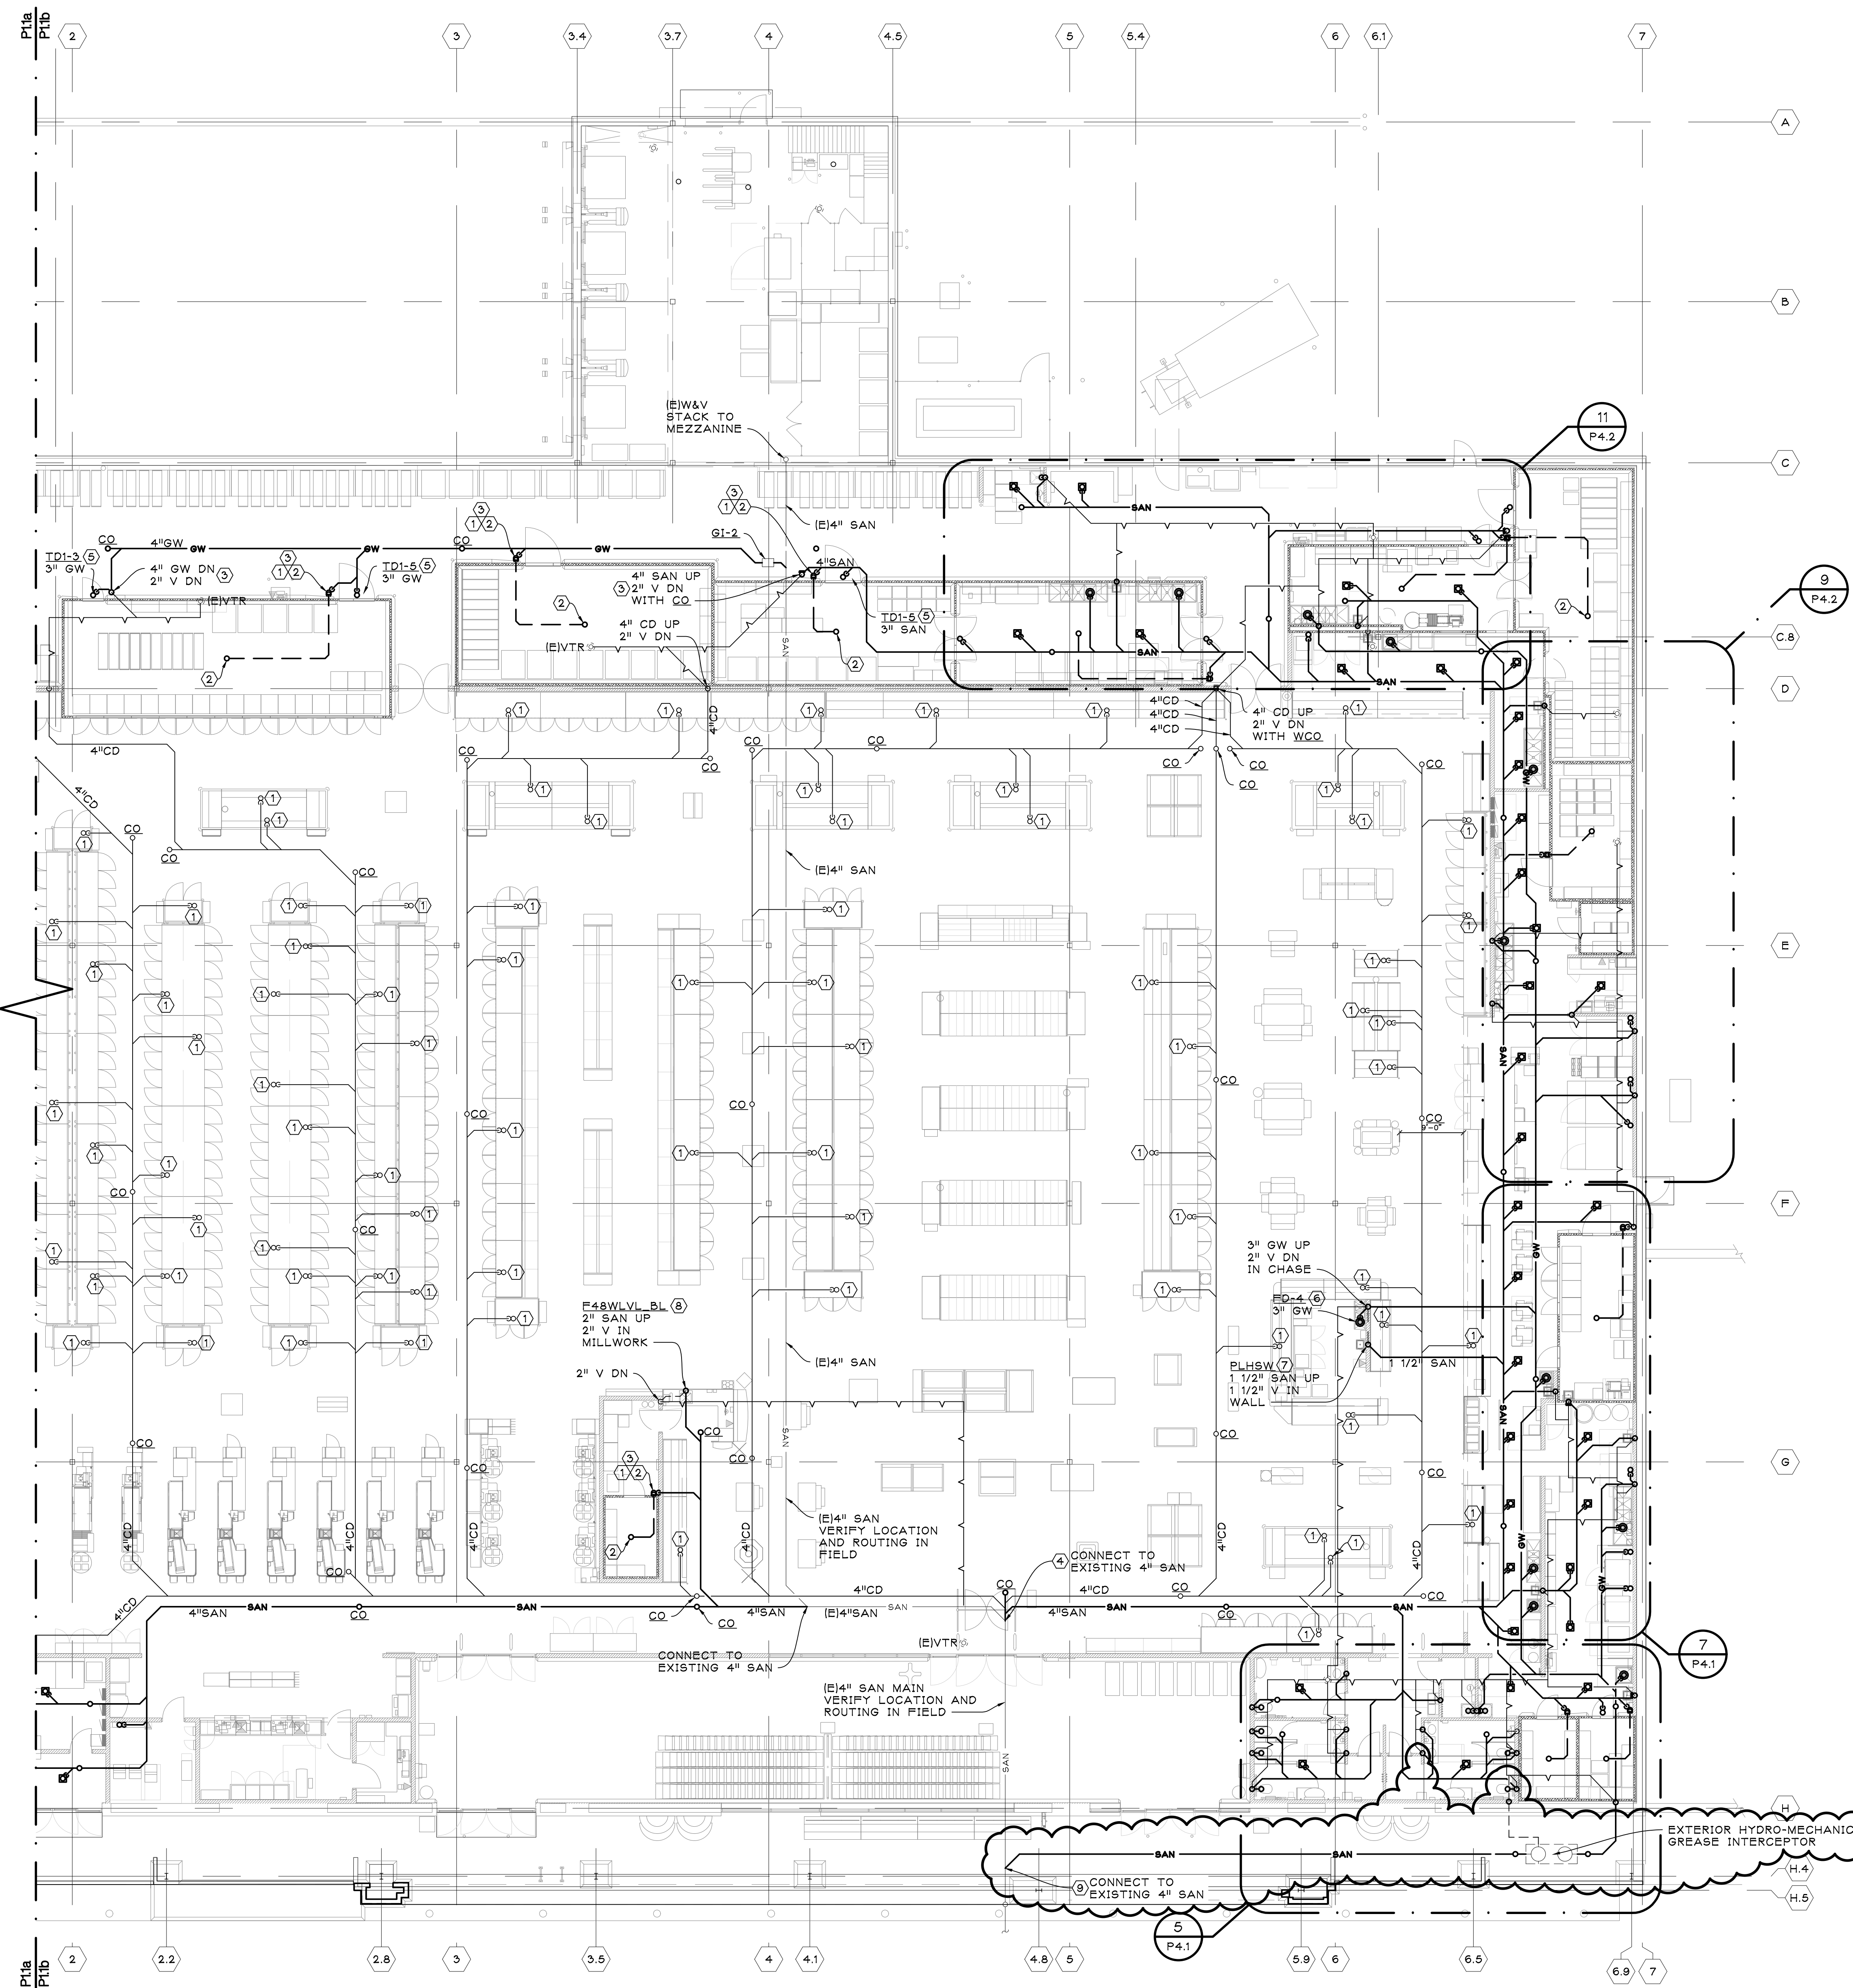


SANITARY & VENT PLAN - NORTH
SCALE: 3/32" = 1'-0"

PLUMBING GENERAL NOTES:

1. REFER TO NOTES ON SHEET P0.1.
2. PROVIDE NEW PLUMBING SERVICES TO FIXTURES AS INDICATED ON PLUMBING FIXTURE SCHEDULE (RE: P6.1).
3. WHERE MULTIPLE DRAINAGE FIXTURES ARE SERVED BY A SINGLE HUB DRAIN, PROVIDE CONCENTRIC 4" COUPLING ON HUB OPENINGS.

KEYED NOTES:

- 1 PROVIDE NEW HUB DRAIN PER PSD-1 (RE: P5.1). PROVIDE 3" HUB DRAIN UNLESS OTHERWISE NOTED ON DRAWING.
- 2 ROUTE CONDENSATE PIPING FOR FREEZER OR COOLER INDOOR COIL UNITS THROUGH WALL AND SPILL INTO HUB DRAIN WITH 2" AIR GAP.
- 3 LOCATE AND ROUTE PLUMBING EQUIPMENT TIGHT TO WALL. PROVIDE PVC SLEEVES AS NECESSARY TO PREVENT DAMAGE IN HEAVY EQUIPMENT AREA. COORDINATE WITH ARCHITECTURAL TRADES.
- 4 VERIFY INVERT ELEVATION OF 8'-4" BELOW SLAB.
- 5 PROVIDE NEW TRENCH DRAIN PER PSD-34 (RE: P5.2). TD1-X WHERE X IS THE LENGTH OF THE TRENCH DRAIN IN FEET.
- 6 INSTALL 3-COMP SINK PER PSD-7 (RE: P5.1). ROUTE 1 1/2" INDIRECT DRAINS FROM EACH COMP TO NEW FLOOR SINK. INSTALL FLOOR SINK PER PSD-188 (RE: 6.2).
- 7 INSTALL HAND SINK WITH FITTINGS AS REQUIRED. PROVIDE 1 1/2" DRAIN TO 1 1/2" SAN UP AND 1 1/2" V ROUTED THROUGH WALL TO ISLAND CHASE. ROUTE VENT DN CHASE FROM NEAREST EXISTING VENT THROUGH ROOF.
- 8 INSTALL FLORAL SINK IN MILLWORK WITH VALVES AND FITTINGS AS REQUIRED. PROVIDE 1 1/2" DRAIN TO 2" SAN UP. PROVIDE 2" VENT ROUTED THROUGH MILLWORK TO FLORAL CHASE. ROUTE VENT DN CHASE FROM NEAREST EXISTING VENT THROUGH ROOF.
- 9 VERIFY INVERT ELEVATION OF 8'-2" BELOW SLAB.

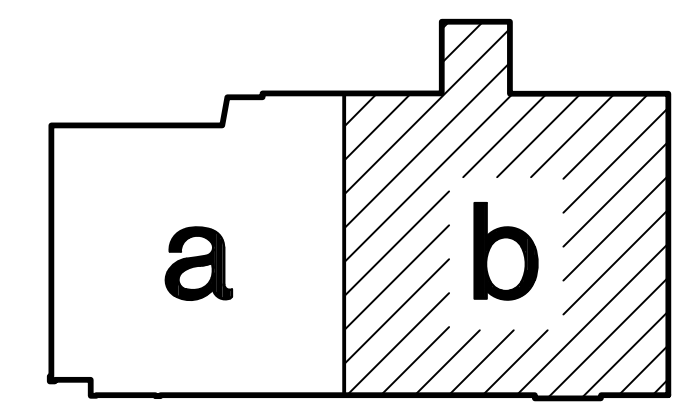

KEY PLAN

BULLETIN NO 2 BIDS AND PERMITS 80% OWNER REVIEW		05/13/2025 02/11/2025 12/19/2024
PROPOSED NEW STORE TAKEOVER FOR: Kroger		
STORE NO. D-416 15100 SILVER PARKWAY FENTON, MI 48430		
THE KROGER CO. OF MICHIGAN		
jeffery a. scott architects p.c.		
32316 grand river ave. suite 200 farmington, michigan 48336-3261 (248) 476-8800 fax (248) 476-8833		
SAN & VENT PLAN - NORTH		
project no.	sheet no.	
24108	P1.1b	